

NATIONAL SENIOR CERTIFICATE

GRADE 12

ENGINEERING GRAPHICS AND DESIGN P1 NOVEMBER 2023

MARKS: 100

TIME: 3 hours

This question paper consists of 6 pages.



INSTRUCTIONS AND INFORMATION


- 1. This question paper consists of FOUR questions.
- 2. Answer ALL the questions.
- 3. ALL drawings are in first-angle orthographic projection, unless otherwise stated.
- 4. ALL drawings must be prepared using pencil and instruments, unless otherwise stated.
- 5. ALL answers must be drawn accurately and neatly.
- 6. ALL the questions must be answered on the QUESTION PAPER, as instructed.
- 7. ALL the pages, irrespective of whether the question was attempted or not, must be re-stapled in numerical sequence in the TOP LEFT-HAND CORNER ONLY.
- 8. Time management is essential in order to complete all the questions.
- 9. Print your examination number in the block provided on every page.
- 10. Any details or dimensions not given must be assumed in good proportion.

FOR OFFICIAL USE ONLY													
QUESTION	MARK	(S OBT	AINED	<u>1</u>	SIGN	МС	DERAT	TED $\frac{1}{2}$ SIGN RE-MARKING $\frac{1}{2}$ SIGN					
1										/			
2													
3													
4													
TOTAL													
_	2	0	0			2	0	0		2	0	0	

FINAL CONVERTED MARK	CHECKED BY
100	

COMPLETE THE FOLLOWING:
CENTRE NUMBER
CENTRE NUMBER
EXAMINATION NUMBER
EXAMINATION NUMBER

Engineering Graphics and Design/P1 NSC DBE/November 2023

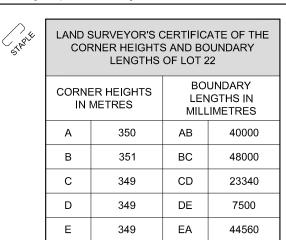

LOT 24

1,8 m HIGH BOUNDARY FENCE

4

FUEL TANKS

-3**-@**

L_@_-

F 64-

BRICK PAVING LAID ON

ALL EXISTING DRIVEWAYS

6000 BL

-EXISTING UNDERGROUND

EXISTING PETROL PUMP 3

EXISTING PETROL PUMP 2

EXISTING
PETROL PUMP 1

150 CONCRETE
APRON

D

ZEBRA CROSSING ON 3,6 m WIDE SPEED HUMP

SITE PLAN

SCALE 1:450

 \mathbb{C}

ELECTRONIC DISPLAY BOARD

7500 (W) x 100 (D) x 2500 (H)

LOT 22

3000 BL

PROPOSED NEW

FAST-FOOD OUTLET

EXISTING BUILDING

6 m EXIT

QUALITY STREET 6 m WIDE

SYMBOL LEGEND:

- 1. PALM TREE
- 2. EVERGREEN TREE
- 3. PARKING FOR PEOPLE WITH DISABILITIES



3

⁷th AVENUE 6 m WIDE

PAVEMENT 2

**

ANSWER 21

ARCHITECT'S SIGNATURE

CLIENT'S SIGNATURE

NOTE:

discrepancies.

In the space below, draw, in neat freehand, the *SANS 10143* graphical symbol for:

(a) SHOWER (elevation and plan

Contractors must verify all dimensions and

levels on site before commencing work.

Architects to be notified immediately of any

- (a) SHOWER (elevation and plan) (b) SOCKET OUTLET
- (a) SHOWER (elevation and plan)
- (b) SOCKET OUTLET

2	04/02/2023	REPLACE 150 CONCRETE APRON
1	30/01/2023	NEW ENTRANCE ADDED
REVISION	DATE	DESCRIPTION
ACE ARC	HITECTS	

ACE ARCHITECTS 17 ALPINE ROAD SPRINGFIELD 4091	ACEARC@AFRICA.COM 031 208 2456

PRINTED BY:	DATE OF PRINT:
PRINTFRIEND PRINTERS	05/02/2023
	-

DRAWING TITLE:

SITE PLAN

PROJECT:

PROPOSED NEW FAST-FOOD OUTLET AND COVERED WALKWAY FOR LAHRIE AND ASSOCIATES, LOT 22, 7th AVENUE, KLOOF

PROJECT NUM	IBER:	DRAWING NUMBER:			
72	846-23	LA - 787976			
DATE:	DRAWN:	CHECKED:	SCALE:		
28/01/2023	S MOTALA	A BUX	1:450		
REFERENCE C	ODE:				
1218	3124				

QUESTION 1: ANALYTICAL (CIVIL)

Given:


The site plan of an existing service station with a proposed new fast-food outlet and a covered walkway, a title panel and a table of questions. The drawing is not presented to the indicated scale.

Instructions:

Complete the table below by neatly answering the questions, which refer to the accompanying drawing, title panel and civil content. [30]

		QUESTIONS ANSWERS	3	
	1	What is the e-mail address of the architectural firm?	1	
	2	What scale is indicated for the site plan?	1	
	3	When was the first revision made to the drawing?	1	
	4	Into which street does the service station exit?	1	
	5	What is the height of the highest corner of LOT 22 in metres?	1	
	6	What is the finish on all the existing driveways?	1	
	7	How many existing underground fuel tanks are shown?	1	
	8	On what feature in the road is the zebra crossing?	1	
	9	What is the fall of the existing sewer line?	1	
	10	What is the height of the electronic display board in millimetres?	1	
	11	What does the abbreviation G at 1 stand for?	1	
N	12	Name the feature at 2.	1	
:	13	What does the feature at 3 indicate?	1	
	14	To what must the new sewerage line be connected?	1	
	15	What is the thickness of the concrete apron in metres?	1	
	16	In what colour must new walkways be indicated on site plans?	1	
Л	17	Which elevation of the new fast-food outlet faces 7th Avenue?	2	
	18	If wall S-S on the new fast-food outlet is 4,8 m from boundary line AB, how far is it from building line T-T in millimetres?	2	
	19	In the space below (ANSWER 19), determine the perimeter of LOT 22 in metres.	3	
	20	In the space below (ANSWER 20), determine the total area of the existing building in square metres.	3	
	21	In the space in the title panel (ANSWER 21), draw, in neat freehand, the SANS 10143 graphical symbol for: (a) SHOWER (elevation and plan) and (b) SOCKET OUTLET.	4	
		TOTAL	30	

ANSWER 19 Show ALL calculations. (Do NOT round off the answer.)

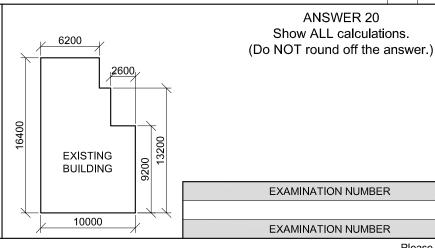

Copyright reserved

В

3000

(1)

NEW SEWER LINE
CONNECTED TO
EXISTING SEWER
LINE

LOT 20

EXISTING SEWER LINE LAID AT 1:40

MUNICIPAL SEWER CONNECTION



QUESTION 2: SOLID GEOMETRY

Given:

NSC


- The front view and top view of a right regular pentagonal pyramid with one base edge in contact with a base edge of a right regular hexagonal prism. The prism is centrally pierced by a right square prismatic hole.
- Cutting plane P-P, that cuts both solids

Instructions:


Draw, to scale 1:1, the following views of both solids:

- 2.1 The given front view
- 2.2 A sectional top view
- 2.3 A sectional left view
- Planning is essential.
- Show ALL hidden detail.
- Show ALL construction.

[38]

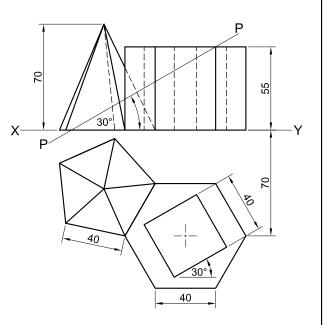

		ASSESSMENT C	RITE	RIA		
	1	SECTIONAL TOP VIEW	$15\frac{1}{2}$			
	2	FRONT VIEW	8 1 2			
	3	SECTIONAL LEFT VIEW	14			
PE	ENA	LTIES (-)				
		TOTAL	38			
		EXAMINATION NU	JMBEF	₹		
		·				
		EXAMINATION NU	JMBEF	2		3

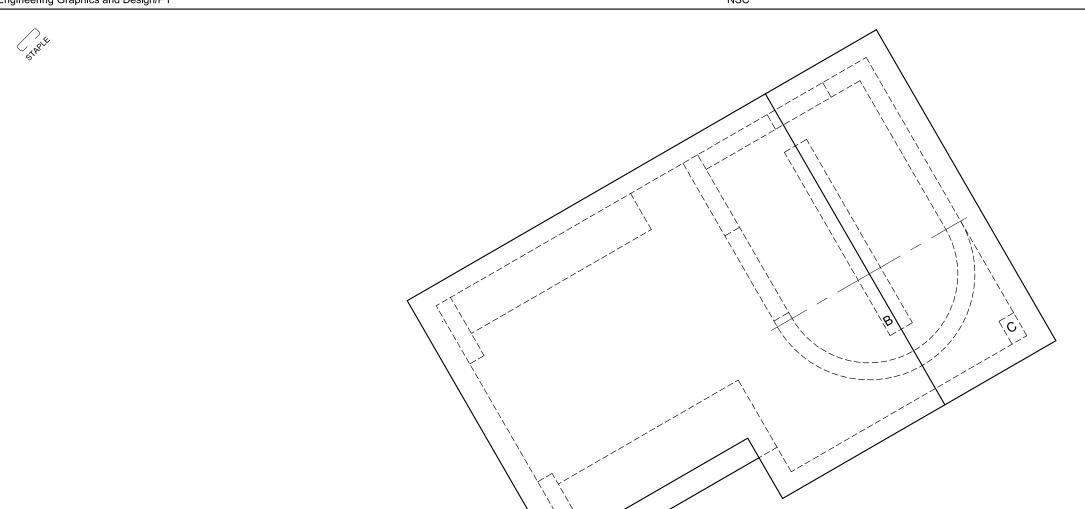

QUESTION 3: PERSPECTIVE

Given:

Three views of a covered drive-through ticket booth and the information needed to draw a two-point perspective drawing PP - Picture plane

HL - Horizon line

GL - Ground line


SP - Station point

Instructions:


Complete the perspective drawing.


- Align the drawing sheet with the ground line (GL).Determine and label the vanishing points.
- Show ALL construction.
- Show depth at the window.
- Show ALL interior detail as seen through the window.
- NO hidden detail is required.

ASSESSMENT CRITERIA						
1	CONSTRUCTION	6				
2	FLOOR	11				
3	WALLS	8 ½				
4	ROOF	4 ½				
5	WINDOWS + ARC	10				
PEN	ALTIES (-)					
	TOTAL	40				

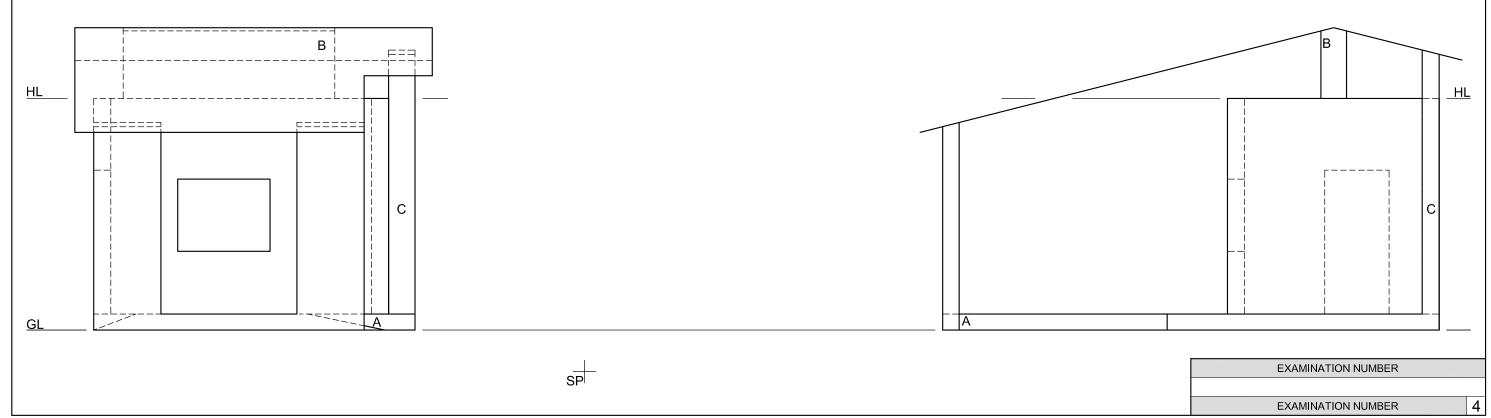

PP

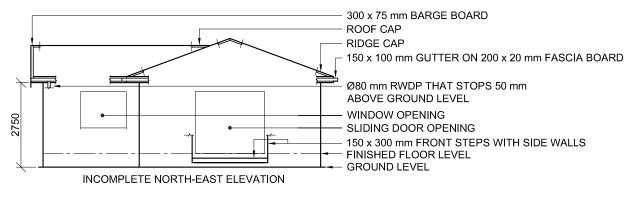

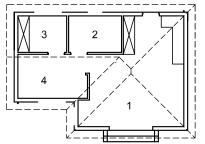

ROOM DESIGNATIONS

DOOR AND WINDOW SCHEDULE

DOOR (D2)

QUESTION 4: CIVIL DRAWING

Given:

- The incomplete north-east elevation of a new house, showing the walls, the window and sliding door openings, the front steps, roof and labels
- The incomplete floor plan showing the walls, front steps, positions of the doors, windows, fixtures and electrical layout
- The front step and side wall detail
- An incomplete schematic diagram of a roof truss at cutting plane A-A and roof notes
- The incomplete foundation and external wall detail
- Room designations and floor finishes
- A door and window schedule
- A table of roof components
- A table of electrical symbols
- A table of fixtures
- The incomplete floor plan and ground level of the new house, drawn to scale 1:50, and the incomplete foundation and break lines for the detailed section, drawn to scale 1:20, on page 6

Instructions:

Answer this question on page 6.

4.1 Using the given incomplete floor plan and ground level, draw, to scale 1:50, the following views of the new

4.1.1 THE COMPLETE FLOOR PLAN Add the following features to the drawing:

- ALL doors and windows
- ALL fixtures as indicated by abbreviations
- ALL electrical fittings as indicated by the numbers
- ALL hatching detail

4.1.2 THE COMPLETE NORTH-EAST ELEVATION Show the following features on the drawing:

- The outside walls, window, sliding door and step detail
- The roof detail including the fascia boards, barge board, gutters and rainwater down-pipe
- The finished floor level
- 4.2 Using the incomplete foundation and break lines on page 6, draw, to scale 1: 20, a **DETAILED SECTION** on cutting plane A-A of the area in the ellipse shown on the incomplete floor plan.

Show the following features on the drawing:

- The complete foundation, external wall, slab and window detail
- The roof detail including ALL rainwater items
- The W2 window, roof and rainwater item detail, to the right (north-west) of cutting plane A-A
- ALL hatching detail. ONLY the substructure hatching may be drawn in neat freehand.


Label the following:

- The floor finishes
- Ground level, finished floor level and damp-proof course (use the correct abbreviations and show them on ALL relevant views)

NOTE:

ALL drawings must comply with the guidelines and graphical symbols as contained in the SANS 10143.

[92]

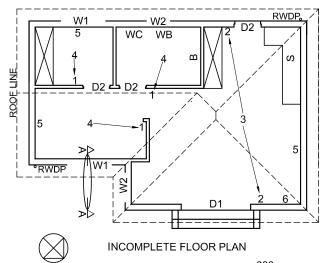

FEATURES

D1 SLIDING DOOR D2 DOOR

WINDOW W1 W2 WINDOW

FIXTURES


BATH В SINK


TOILET WC WB WASH BASIN

ELECTRICAL FITTINGS

- 1. ONE-WAY SWITCH SINGLE-POLE
- 2. TWO-WAY SWITCH
- 3. FLUORESCENT LIGHT 4 x 40 W 4. CEILING LIGHT
- 5. SWITCHED SOCKET OUTLET 6. DISTRIBUTION BOARD

THE ARROW SHOWS THE LIGHT CONNECTION TO THE SWITCH.

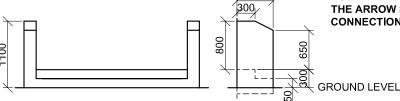

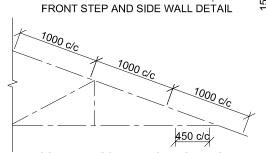

INCOMPLETE SCHEMATIC DIAGRAM OF A ROOF TRUSS AT CUTTING PLANE A-A

ROOF NOTES:

20° ROOF PITCH

114 x 40 mm ROOF TRUSSES ON 114 x 40 mm WALL PLATES


400 mm ROOF OVERHANG TO END OF **ROOF TRUSS**


40 mm CORRUGATED ROOF SHEET ON 75 x 50 mm PURLINS @ 1000 mm c/c

300 x 75 mm BARGE BOARD ON GABLE ENDS AND 200 x 20 mm FASCIA BOARD WITH

10 mm CEILING BOARD ON 40 x 40 mm BRANDERING STRIPS @ 450 mm c/c

150 x 100 mm GUTTERS ON ALL SIDES

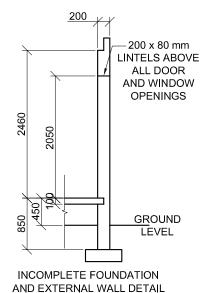

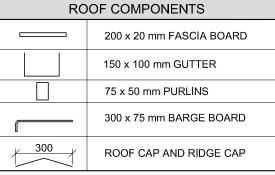

• 200 x 20 mm FIBRE CEMENT SILL UNDER ALL WINDOWS

TO FIT

SLIDING DOOR (D1)

• ALL FRAMES = 50 mm THICK

WINDOW NOTES:


• A = OPENING SIDE

B = FIXED PANEL

600

В

В

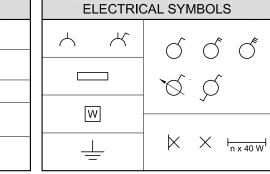

FLOOR FINISHES

1. OPEN AREA

2. BATHROOM:

3. BEDROOM:

4. OFFICE:

TILE

TILE

1500

R

WINDOW (W1)


В

WINDOW (W2)


500

CARPET

LAMINATE

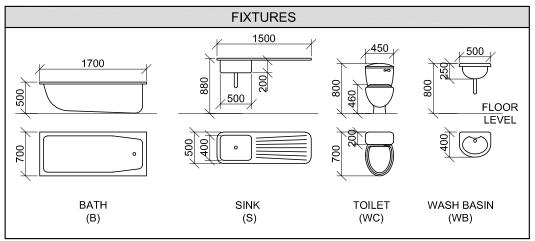

Copyright reserved

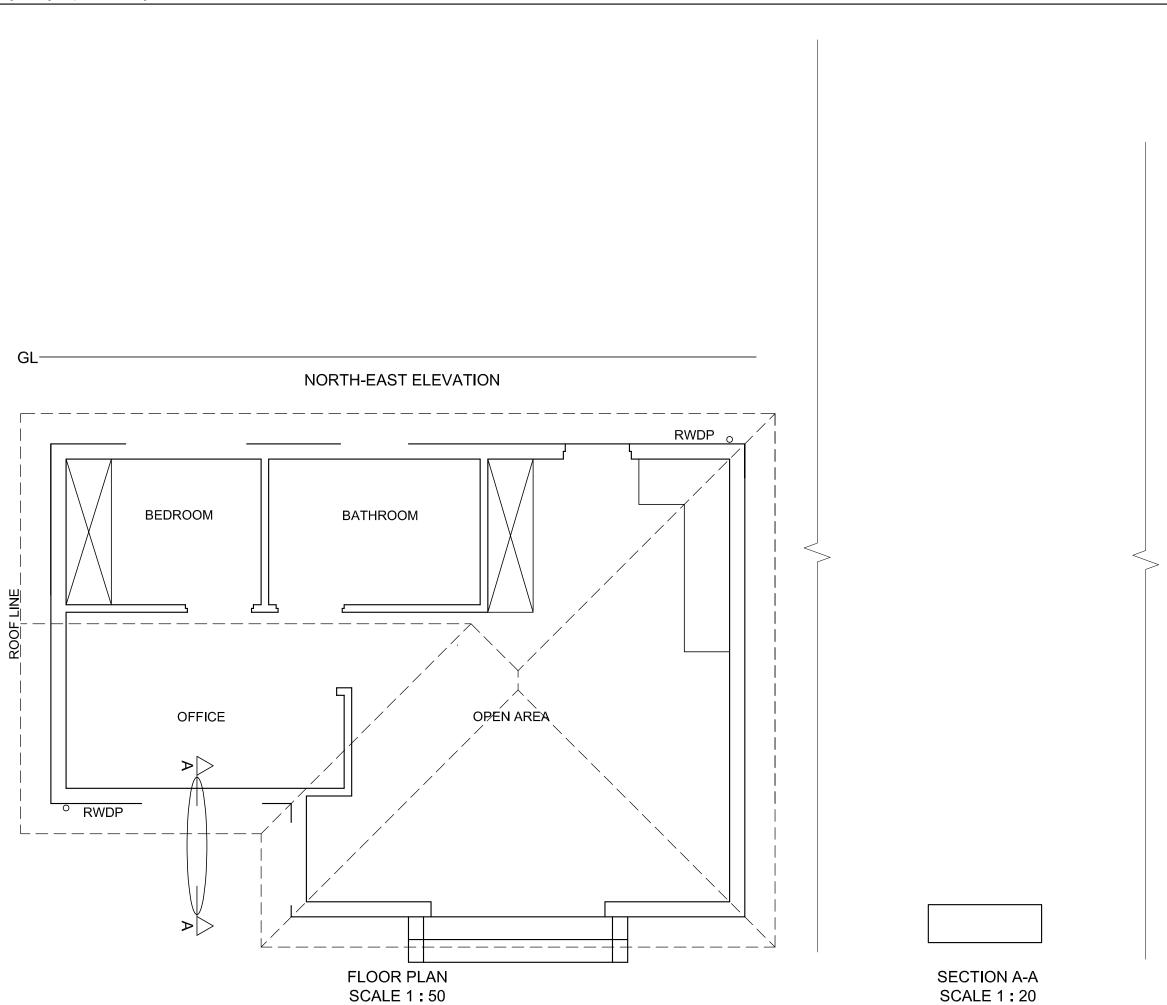

MARK ALLOCATION FOR		FOR OFFICIAL USE ONLY			
SECTION	OF ROOF	INCORRECT			
Α		SCALE(S) USED			
В		NON-ALIGNMENT OF VIEWS			
С		VIEW(S) ROTATED			
D		SECTION VIEWED			
E		INCORRECTLY			
F		INCORRECT LETTERING			
G					
Н					
J					
TOTAL		TOTAL			

	ASS	ESSME	NT CRITE	ERIA				
	FLOOR PLAN							
		POSSIBLE	OBTAINED	SIGN	MODERATED			
1	DOORS + WINDOWS	13 ½						
2	FIXTURES	8						
3	ELECTRICAL	9 1 2						
4	HATCHING	3						
5	LABELS	2						
sı	JBTOTAL	36						
	NOR	TH-EAS	ΓELEVA	TION				
1	ROOF + RWDP	8 1 2						
2	WALLS + STEPS	7						
3	DOOR + WINDOW	8						
4	LABELS	<u>1</u> 2						
SI	JBTOTAL	24						
	D	ETAILEC	SECTIO	N				
1	ROOF DETAIL	$13\frac{1}{2}$						
2	SLAB + WALL	$4\frac{1}{2}$						
3	HATCHING	5 ½						
4	WINDOWS	7						
5	LABELS	1 ½						
SI	JBTOTAL	32						
	TOTAL	92						
PEN	PENALTIES (-)							
	GRAND	TOTAL						
	E	KAMINATIC	N NUMBER	₹				
	EXAMINATION NUMBER 6							