

## NATIONAL SENIOR CERTIFICATE


**GRADE 12** 

# ENGINEERING GRAPHICS AND DESIGN P1 NOVEMBER 2022

**MARKS: 100** 

TIME: 3 hours

#### This question paper consists of 6 pages.

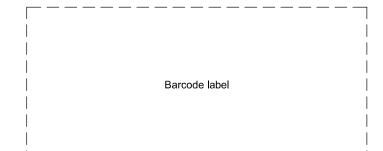



- 1. This question paper consists of FOUR questions.
- 2. Answer ALL the questions.
- 3. ALL drawings are in first-angle orthographic projection, unless otherwise stated.
- 4. ALL drawings must be prepared using pencil and instruments, unless otherwise stated.
- 5. ALL answers must be drawn accurately and neatly.
- 6. ALL the questions must be answered on the QUESTION PAPER, as instructed.
- 7. ALL the pages, irrespective of whether the question was attempted or not, must be re-stapled in numerical sequence in the TOP LEFT-HAND CORNER ONLY.
- 8. Time management is essential in order to complete all the questions.
- 9. Print your examination number in the block provided on every page.
- 10. Any details or dimensions not given must be assumed in good proportion.

FOR OFFICIAL USE ONLY															
QUESTION	MARK	(S OBT	AINED	<u>1</u>	SIGN	МС	DERAT	ED	1/2	SIGN	RE	RE-MARKING $\frac{1}{2}$ SIC		SIGN	
1															
2															
3															
4															
TOTAL															
	2	0	0			2	0	0			2	0	0		

FINAL CONVERTED MARK	CHECKED BY
100	

COMPLETE THE FOLLOWING:
CENTRE NUMBER
CENTRE NUMBER
EXAMINATION NUMBER
EXAMINATION NUMBER

DO NOT FOLD THIS QUESTION PAPER IN HALF.

NSC Engineering Graphics and Design/P1 DBE/November 2022

STAPLE	LAND SURVEYOR'S CERTIFICATE OF THE CORNER HEIGHTS AND BOUNDARY LENGTHS OF STAND 3414				
		ER HEIGHTS METRES	BOUNDARY LENG IN MILLIMETRE		
	А	1600	АВ	24230	
	В	1600	вс	8370	
	C	1599	CD	18380	

1599

1601

DE

EΑ

31200

32400

D

Е

SYMBOL LEGEND				
	EVERGREEN TREES			
0	BUSHES			
-× ×	2000 HIGH SECURITY FENCE			
	1800 HIGH PALLISADE FENCE			

## N3 NATIONAL ROAD 15 m ROAD RESERVE МН 3600 BL EXISTING SEWERAGE LINE PROPOSED NEW **STAND 3414 EXTENSION** (2) (3) 2500 BL **STAND 3413** 3.6 m WIDE VEHICLE ENTRY DOMBEYA STREET

SITE PLAN SCALE 1:350

#### NOTE:


Contractors must verify all dimensions and levels on site before commencing work. Architects to be notified immediately of any discrepancies.

ARCHITECT'S SIGNATURE .....

CLIENT'S SIGNATURE ...

#### **ANSWER 18**

In the space below, draw, in neat freehand, the SANS 10143 hatching (symbol) for a (18.1) FACE BRICK WALL, and graphical symbol for a (18.2) STAIRCASE.

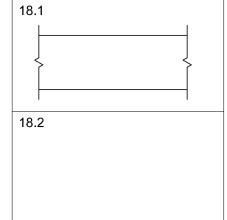

2	07/01/22	ADD WATER METER	LISA B
1	06/01/22	COLOUR NEW ADDITION RED	LISA B
REVISION	DATE	DESCRIPTION	DRAWN

KOMBELLA, JOUBERT & MINNAAR ARCHITECTURAL DESIGN 365 BORCHARDS AVENUE ERASMIA 0183

www.kjmdesign.co.za

PRINTED BY: DATE OF PRINT: STEVENS PRINTERS 08/01/2022

DRAWING TITLE:

012 685 1857

SITE PLAN

#### PROJECT:

PROPOSED NEW ADDITION FOR MR N KEENAN ON STAND 3414, 21 DOMBEYA STREET, HARRISMITH

PROJECT NUM	IBER:	DRAWING NUMBER:			
FTW	/2022-59	1 OF 5			
DATE:	DRAWN:	CHECKED:	SCALE:		
05/01/2022	CASPER	ANNIE Q	1:350		
REFERENCE C	ODE:				


#### **QUESTION 1: ANALYTICAL (CIVIL)**


The site plan of an existing house with a proposed new extension, a title panel and a table of questions. The drawing has not been presented to the indicated scale.

#### Instructions:

Complete the table below by neatly answering the questions, which refer to the accompanying drawing, title panel and civil content.

)		QUESTIONS ANSWERS	S	
	1	What does the number FTW2022-59 refer to?	1	
	2	Who is the client?	1	
	3	What is the title of the drawing?	1	
	4	What action was taken on 08/01/2022?	1	
	5	Who was responsible for preparing the revisions to the drawing?	1	
	6	How wide is the road reserve in millimetres?	1	
	7	Whose signatures are required on the site plan?	2	
	8	How many new inspection eyes are shown on the site plan?	1	
	9	What does the abbreviation RWDP stand for?	1	
	10	Which corner of STAND 3414 is the highest?	1	
	11	Determine the shortest distance from the proposed new extension to boundary line AB in metres.	1	
	12	What is indicated in BLUE on floor plans and/or sections?	2	
В	13	Name the feature at 1.	1	
ιВ	14	What is indicated by the arcs at 2?	1	
	15	Name the feature at 3.	1	
٧N	16	What does the ratio 1:40 on the new sewerage line indicate?	1	
	17	Which elevation of the existing house faces the N3 national road?	2	
	18	In the space in the title panel (ANSWER 18), draw, in neat freehand, the SANS 10143 hatching (symbol) for a (18.1) FACE BRICK WALL, and graphical symbol for a (18.2) STAIRCASE.	4	
	19	In the space below (ANSWER 19), determine the total length of the 1800 high pallisade fence required for STAND 3414, in metres.	3	
	20	In the space below (ANSWER 20), determine the total area of the house, including the new extension, in square metres. Show the answer to TWO decimal places.	3	
		TOTAL	30	

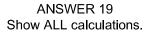

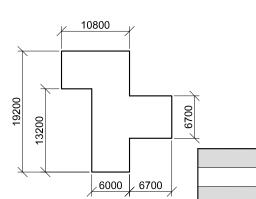

**ANSWER 20** Show ALL calculations.

**EXAMINATION NUMBER EXAMINATION NUMBER** 



#### **QUESTION 2: SOLID GEOMETRY**

#### Given:


- The front view and top view of a right square pyramid that rests against a right regular pentagonal prism
- An auxiliary view of the right square pyramid
- Cutting plane R-R

#### Instructions:

Draw, to scale 1: 1, the following views of both solids:


- 2.1 The given front view
- 2.2 A sectional top view with the parts above cutting plane R-R removed
- 2.3 A sectional right view with the parts below cutting plane R-R removed
- 2.4 The true shape of the cut surfaces of BOTH solids
- Planning is essential.
- Show ALL hidden detail.
- Show ALL construction.

[37]

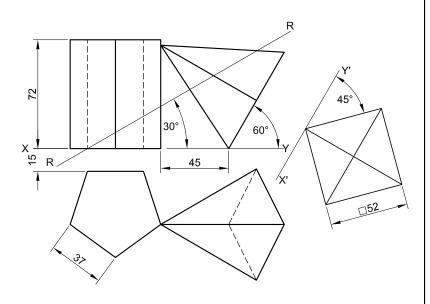

	ASSESSMENT CI	RITER	RIA		
1	FRONT VIEW	7			
2	SECTIONAL TOP VIEW	12 ½			
3	SECTIONAL RIGHT VIEW	10			
4	TRUE SHAPE	$6\frac{1}{2}$			
5	CORRECT HATCHING	1			
PENA	ALTIES (-)				
	TOTAL	37			
	EXAMINATION NU	MBER			
	EXAMINATION NU	MBER			3

Engineering Graphics and Design/P1 NSC DBE/November 2022

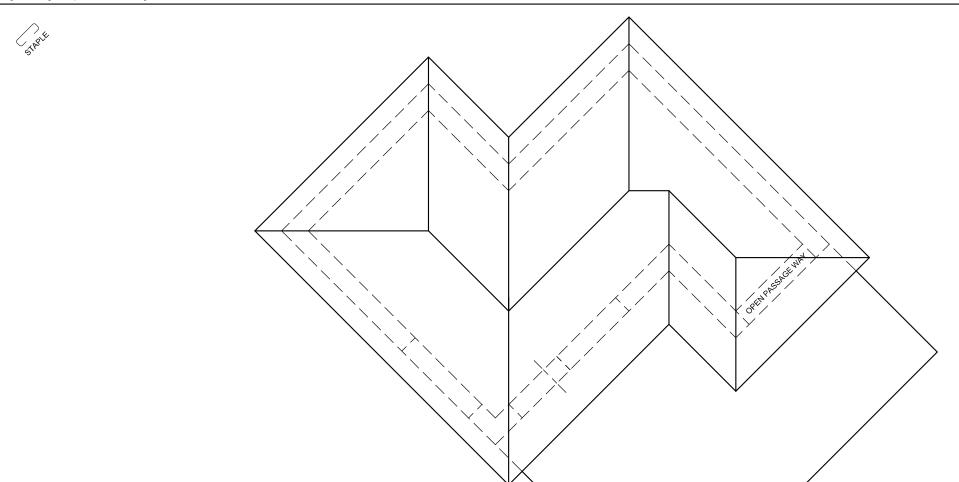

#### **QUESTION 3: PERSPECTIVE**

#### Given:

Three views of a club house and the information needed to draw a two-point perspective drawing PP - Picture plane

HL - Horizon line

GL - Ground line

SP - Station point


#### Instructions:


Complete the perspective drawing.

- Align the drawing sheet with the ground line (GL).
- Determine and label the vanishing points.
- Show ALL construction.
- Show depth at the windows.
- NO hidden detail is required.


[41]

ASSESSMENT CRITERIA						
1	CONSTRUCTION	6				
2	WALL + BASE	11				
3	WINDOWS + OPENING	10				
4	ROOF	7 ½				
5	ARC	6 ½				
PEN	IALTIES (-)					
	TOTAL	41			·	

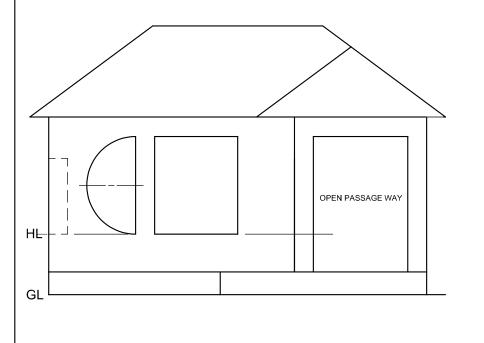

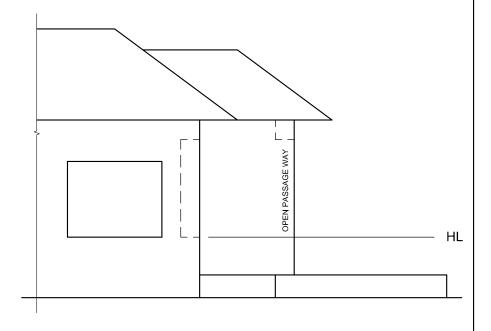

EXAMINATION NUMBER **EXAMINATION NUMBER** 

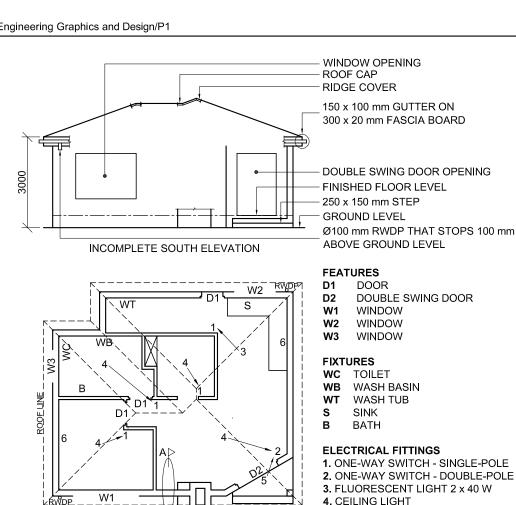

INCOMPLETE FLOOR PLAN

INCOMPLETE SCHEMATIC DIAGRAM OF

A ROOF TRUSS

900 c/c

540 c/c

900 c/c

114 x 40 mm ROOF TRUSSES ON

300 mm ROOF OVERHANG TO END OF

75 x 50 mm PURLINS @ 900 mm c/c

300 x 20 mm FASCIA BOARDS WITH

150 x 100 mm GUTTERS ON ALL SIDES

10 mm CEILING BOARD ON 40 x 40 mm BRANDERING STRIPS @ 540 mm c/c

20 mm CORRUGATED ROOF SHEETING ON

114 x 40 mm WALL PLATES

- 2. ONE-WAY SWITCH DOUBLE-POLE 3. FLUORESCENT LIGHT 2 x 40 W
- 5. WALL-MOUNTED LIGHT
- 6. SWITCHED SOCKET OUTLET


#### NOTE:

INCOMPLETE FOUNDATION


AND EXTERNAL WALL DETAIL

THE ARROW SHOWS THE LIGHT CONNECTION TO THE SWITCH.

200

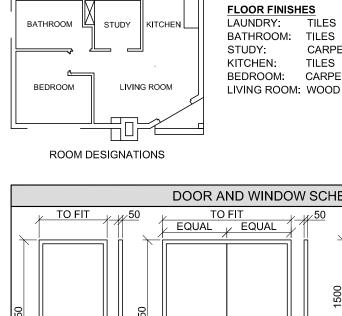

LAUNDRY

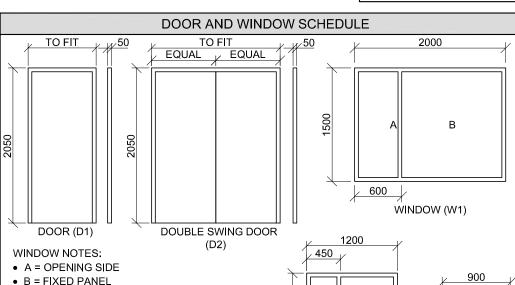


TILES

TILES

TILES

CARPET

CARPET

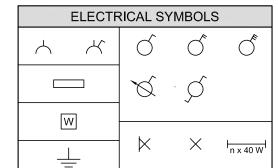


• 150 x 20 mm FIBRE CEMENT SILL UNDER ALL

• ALL FRAMES = 50 mm


WINDOWS

(WB)

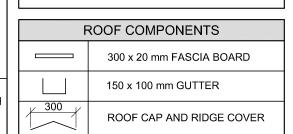

WINDOW (W2)

(B)

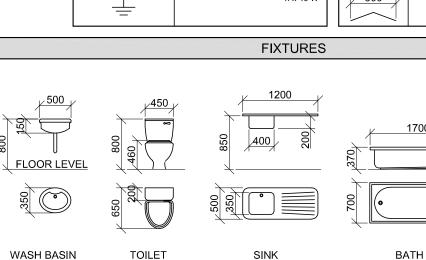

(S)

(WC)

#### **QUESTION 4: CIVIL DRAWING**

#### Given:

CHIMNEY DETAIL

1100

45°

- The incomplete south elevation of a **new house**, showing the walls, window and double swing door openings, step, position of the chimney, roof and labels
- The incomplete floor plan showing the walls, step, positions of the doors, windows, chimney and fixtures, as well as electrical
- An incomplete schematic diagram of a roof truss and roof notes
- The incomplete foundation and external wall detail
- Room designations and floor finishes
- A table with chimney detail
- A door and window schedule
- A table of electrical symbols
- A table of roof components
- A table of fixtures
- The incomplete floor plan and position of the ground level of the **new house**, drawn to scale 1:50, and the incomplete foundation and a break line for the detailed section, drawn to scale 1: 20, on page 6.

#### **Instructions:** Answer this question on page 6.

4.1 Using the given incomplete floor plan and ground level, draw, to scale 1:50, the following views of the new

#### 4.1.1 THE COMPLETE FLOOR PLAN

#### Add the following features to the drawing:

- ALL doors and windows
- ALL fixtures as indicated by the abbreviations
- ALL electrical fittings as indicated by the numbers
- ALL the roof lines
- ALL hatching detail

### 4.1.2 THE COMPLETE SOUTH ELEVATION

#### Show the following features on the drawing:

- The outside walls, step, chimney, window and double swing door detail
- The roof detail, including the fascia boards, gutters and rainwater down-pipe
- The finished floor level
- 4.2 Using the given incomplete foundation and break line on page 6, draw, to scale 1: 20, a **DETAILED SECTION** on cutting plane A-A of the area in the ellipse shown on the incomplete floor plan.

#### Show the following features on the drawing:

- The complete foundation and external wall detail
- The roof detail, including the fascia board and gutter
- The chimney and the double swing door and frame to the right (east) of cutting plane A-A
- ALL hatching detail, ONLY the substructure hatching may be drawn in neat freehand.

### Label the following:

- The south elevation
- The floor finishes
- Ground level, finished floor level and damp-proof course (use the correct abbreviation and show it on ALL relevant views).

#### NOTE:

WASH TUB

(WT)


All drawings must comply with the guidelines and graphical symbols as contained in the SANS 10143. [92]

ROOF NOTES:

**ROOF TRUSS** 

20° ROOF PITCH

5

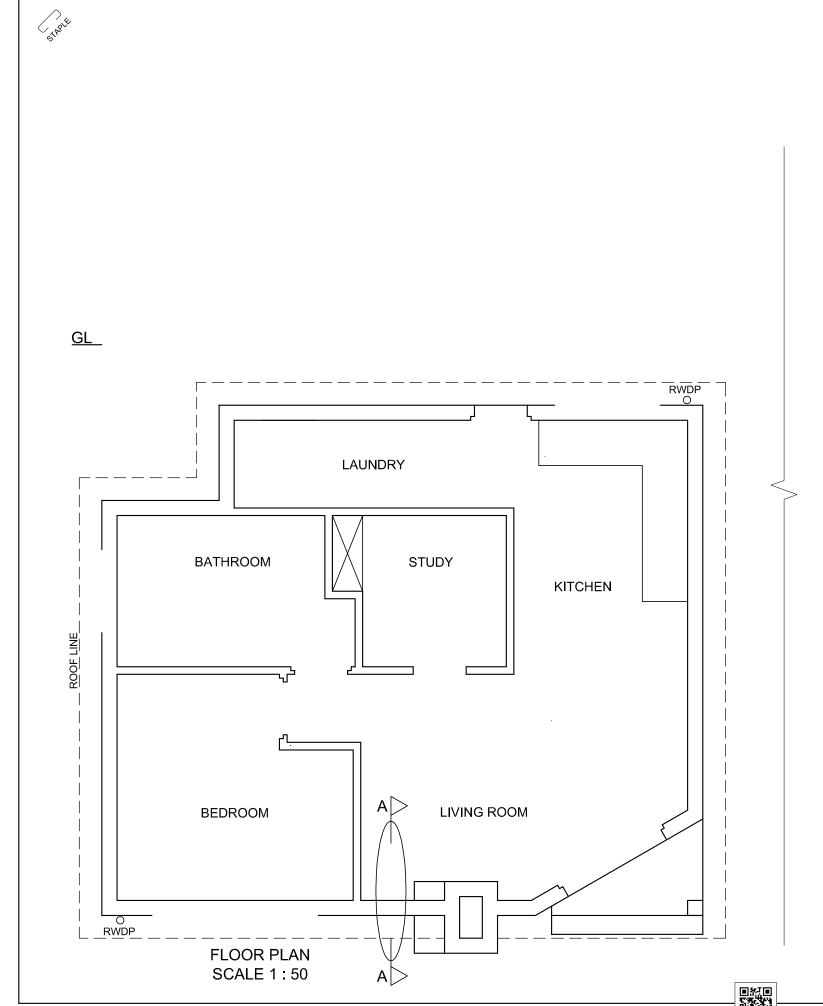

MARK ALLOCATION FOR SECTION OF ROOF		FOR OFFICIAL USE ONLY			
		INCORRECT SCALE(S)			
		USED			
В		NON-ALIGNMENT OF VIEWS			
С		VIEWS			
D		VIEW(S) ROTATED			
E		SECTION VIEWED			
F					
G		INCORRECT LETTERING			
Н					
TOTAL		TOTAL			

	ASSESSMENT CRITERIA							
FLOOR PLAN								
		POSSIBLE	OBTAINED	SIGN	MODERATED			
1	DOORS + WINDOWS	11						
2	FIXTURES + ROOF LINES	15						
3	ELECTRICAL	10						
4	HATCHING	3						
5	LABELS	3						
S	UBTOTAL	42						
	S	OUTH EL	EVATIO	N				
1	ROOF + RWDP	8 <del>1</del> 2						
2	WALLS + STEP + CHIMNEY + FFL	7						
3	DOOR + WINDOW	7						
4	LABELS	1						
S	UBTOTAL	$23\frac{1}{2}$						
	DE	TAILED	SECTIO	N				
1	ROOF DETAIL	11 ½						
2	SLAB + WALL + CHIMNEY	8						
3	HATCHING	3 <del>1</del> 2						
4	DOOR	$2\frac{1}{2}$						
5	LABELS	1						
S	UBTOTAL	26 ½						
	TOTAL	92						
PEN	NALTIES (-)							
	GRAND	TOTAL						
	EXAMINATION NUMBER							
	EXAMINATION NUMBER 6							

SECTION A-A SCALE 1:20