

NATIONAL SENIOR CERTIFICATE

GRADE 12

ENGINEERING GRAPHICS AND DESIGN P1 NOVEMBER 2019

MARKS: 100

TIME: 3 hours

INSTRUCTIONS AND INFORMATION


- 1. This question paper consists of FOUR questions.
- 2. Answer ALL the questions.
- 3. ALL drawings are in first-angle orthographic projection, unless otherwise stated.
- 4. ALL drawings must be prepared using pencil and instruments, unless otherwise stated.
- 5. ALL answers must be drawn accurately and neatly.
- 6. ALL the questions must be answered on the QUESTION PAPER, as instructed.
- 7. ALL the pages, irrespective of whether the question was attempted or not, must be re-stapled in numerical sequence in the TOP LEFT-HAND CORNER ONLY.
- 8. Time management is essential in order to complete all the questions.
- 9. Print your examination number in the block provided on every page.
- 10. Any details or dimensions not given must be assumed in good proportion.

FOR OFFICIAL USE ONLY															
QUESTION	MARK	(S OBT	AINED	1/2	SIGN	МО	DERAT	ED	1/2	SIGN	RE	-MARKI	NG	1/2	SIGN
1															
2															
3															
4															
TOTAL	_														
	2	0	0			2	0	0			2	0	0		

FINAL CONVERTED MARK	CHECKED BY
100	

This question paper consists of 6 pages.

| | | Barcode label | |

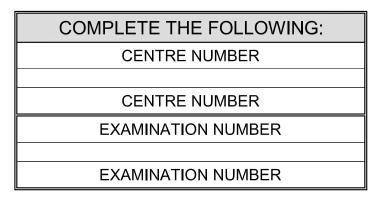



Copyright reserved

Please turn over

Engineering Graphics and Design/P1 NSC

STAPLE	LAND SURVEYOR'S THE CORNER I BOUNDARY LENGTH SURVEYED O	HEIGHTS AND HS OF STAND 2045
	CORNER HEIGHTS IN METRES	BOUNDARY LENGTHS IN METRES

AB = 16,06

BC = 7,05CD = 23,36

DE = 26,41

EF = 18,07

FG = 53,16

GA = 47,69

A = 876.0

B = 876,1

C = 876,0 D = 876,3

E = 876,3

F = 876,4

G = 876,4

SYI	MBOL	LEGEND:	

1. DECIDUOUS TREES




2. SHRUBBERY

4. GRAVEL PATHWAY

3. FRENCH DRAIN

AMUSEMENT PARK

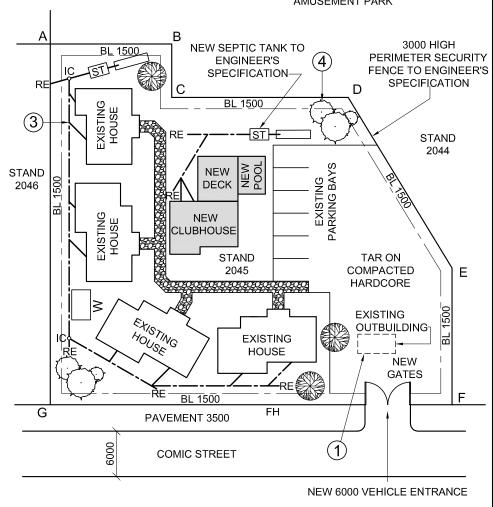

SITE PLAN
SCALE 1:500

NOTE:

Contractors must verify all dimensions and levels on site before commencing work.

Architects to be notified immediately of any discrepancies.

ARCHITECT'S SIGNATURE:

CLIENT'S SIGNATURE: .

ANSWER 20

In the space below, draw, in neat freehand, the front view and top view of the *SANS 10143* graphical symbol for a SINGLE WALL-MOUNTED URINAL.

	<u> </u>	1	
 3	2018-12-20	ADD SWING	

)	2010-12-20	GATES
2	2018-11-18	ADD SEWER LINES
1	2018-11-17	REMOVE DECIDUOUS TREE
REVISION	DATE	DESCRIPTION
CREAT		

CREATIVE ARCHITECTS 777 BEREA ROAD DURBAN	www.c-arch.cc 031 334 976
PRINTED BY:	DATE OF PRINT:
KRYPTON (PTY) LTD	2018-12-28

DRAWING TITLE:

SITE PLAN

PROJECT:

PROPOSED CLUBHOUSE, DECK AND POOL FOR LOIS CHALET ON STAND 2045, 4 COMIC STREET, DURBAN, 4091

IBER:	DRAWING NUMBER:		
)18	1818	3	
DRAWN:	CHECKED:	SCALE:	
CLARK	KENT	1:500	
ODE:			
N-2018			
	DRAWN: CLARK CODE:	D18 1818 DRAWN: CHECKED: CLARK KENT ODE:	

QUESTION 1: ANALYTICAL (CIVIL)

iven:


The site plan of an existing housing development with a proposed new club facility, a title panel and a table of questions. The drawing has not been prepared to the indicated scale.

Instructions:

Complete the table below by neatly answering the questions, which refer to the accompanying drawing, title panel and civil content. [30]

		QUESTIONS ANSWERS	3	
.	1	Who prepared the drawing?	1	
ıt v	2	What is the drawing number?	1	
ol O	3	What company printed the drawing?	1	
۱	4	On what date was the last revision made?	1	
	5	What must the contractors do before commencing with any work?	1	
	6	What is the finish on the pathway?	1	
	7	How wide is the new entrance to STAND 2045 in metres?	1	
	8	What is the STAND number of the amusement park?	1	
	9	What colour is used to represent new sewer lines on a drainage plan?	1	
	10	What does the abbreviation <i>BIC</i> stand for?	1	
	11	What does the broken line at 1 indicate?	1	
	12	What does the symbol at 2 indicate?	1	
	13	What is the abbreviation of the component that you will find at the junction at 3?	1	
	14	Name the feature at 4.	1	
≣S —	15	What are the final TWO components of the sewerage system?	2	
E	16	Which elevation of the clubhouse faces Comic street?	1	
1	17	What features make up the new club facility?	3	
	18	In the space below (ANSWER 18), determine the total length of the perimeter of STAND 2045 in metres.	3	
	19	In the space below (ANSWER 19), determine the total area of the new club facility in square metres.	3	
	20	In the space in the title panel (ANSWER 20), draw, in neat freehand, the front view and top view of the SANS 10143 graphical symbol for a SINGLE WALL-MOUNTED URINAL.	4	
_		TOTAL	30	

ANSWER 18 Show ALL calculations.

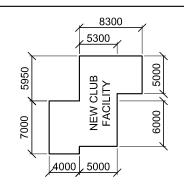

ANSWER 19
Show ALL calculations.

EXAMINATION NUMBER

EXAMINATION NUMBER 2

Please turn over

Copyright reserved



QUESTION 2: INTERPENETRATION AND DEVELOPMENT

Given:


- The top view and incomplete front view of a right regular hexagonal prism that has been shaped to fit over an equilateral triangular prism. The axes of both solids lie in a common vertical plane.
- An auxiliary view of the triangular prism

Instructions:

Draw, to scale 1: 1, the following views of the TWO solids:

- 2.1 The given top view
- 2.2 The right view
- 2.3 The complete front view, clearly showing the curve of interpenetration
- 2.4 The development of the surface of the hexagonal prism. Make edge 'A' the seam.
- Planning is essential.
- Show ALL hidden detail.
- Show ALL construction.


[37]

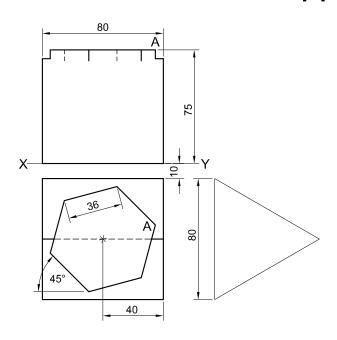

EDGE 'A' IS THE SEAM

	ASSESSMENT CRITERIA					
1	TOP VIEW	7 ½				
2	RIGHT VIEW	5				
3	FRONT VIEW	13				
4	DEVELOPMENT	11 ½				
PENA	PENALTIES (-)					
	TOTAL 37					
	EXAMINATION NUMBER					
	EXAMINATION N	UMBER			3	



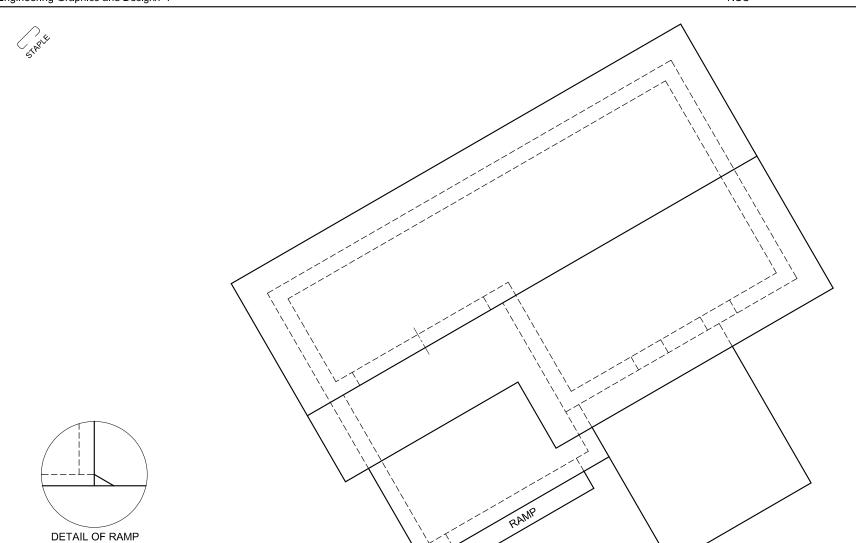

QUESTION 3: PERSPECTIVE

Given:

Two views of a house with a pitched roof, the detail of the ramp and the information needed to draw a two-point perspective drawing

PP - Picture plane

HL - Horizon line

GL - Ground line

SP - Station point

Instructions:

Complete the perspective drawing.

- Align the drawing sheet with the ground line
- Determine and label the vanishing points.
- Show ALL construction.
- NO interior detail is required.
- NO hidden detail is required.

[39]

ASSESSMENT CRITERIA				
1	CONSTRUCTION	6		
2	WALLS	13		
3	DOORS + WINDOWS	8 ½		
4	ROOF	4 ½		
5	ARCS	7		
PEN	ALTIES (-)			
	TOTAL	39		

EXAMINATION NUMBER

HL GL RAMP EXAMINATION NUMBER

HL

GL

PP

SP

2

CARPET

CARPET

TILES

ROOM DESIGNATIONS


FLOOR FINISHES

1. LOUNGE:


2. KITCHEN:


3. BEDROOM:

4 BATHROOM.

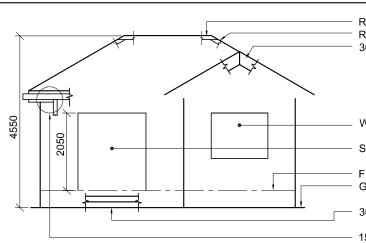

INCOMPLETE NORTH ELEVATION

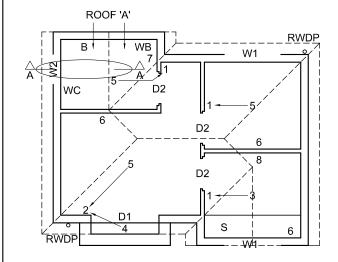

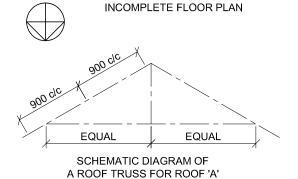

ROOF NOTES:

30° ROOF PITCH

115 x 40 mm ROOF TRUSSES ON 115 x 40 mm WALL PLATES

300 mm ROOF OVERHANG TO END OF ROOF

20 mm FIBRE CEMENT ROOF SHEETING ON 75 x 50 mm PURLINS @ 900 mm c/c

300 x 20 mm FASCIA BOARD WITH 150 x 150 mm GUTTERS ON ALL SIDES

300 x 30 x 5 mm BARGE BOARDS ON GABLE ENDS, 40 mm PAST THE GUTTERS

8 mm CEILING BOARD ON 40 x 40 mm BRANDERING STRIPS @ 600 mm c/c



WINDOW OPENING

SLIDING DOOR OPENING

FINISHED FLOOR LEVEL **GROUND LEVEL**

300 x 150 mm STEPS

150 x 150 mm GUTTER ON 300 x 20 mm FASCIA BOARD WITH Ø100 mm RWDP THAT STOPS 50 mm OFF THE **GROUND LEVEL**

FEATURES

D1 + D2 DOORS W1 + W2 WINDOWS

FIXTURES


TOILET WC WB WASH BASIN В BATH SINK

ELECTRICAL FITTINGS


- 1. ONE-WAY SWITCH SINGLE-POLE 2. ONE-WAY SWITCH - DOUBLE-POLE
- 3. FLUORESCENT LIGHT 3 x 40 W
- 4. WALL-MOUNTED LIGHT
- 5. CEILING LIGHT
- 6. SWITCHED SOCKET OUTLET
- 7. SOCKET OUTLET
- 8. DISTRIBUTION BOARD

NOTE:

THE ARROW SHOWS THE LIGHT CONNECTION TO THE SWITCH.

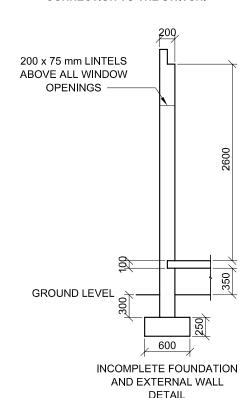




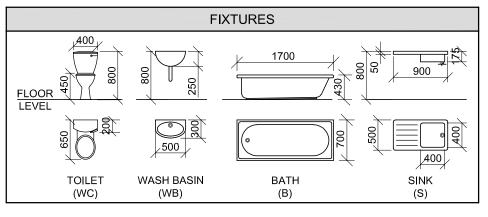

DOOR NOTE:

ALL FRAMES 50 mm THICK

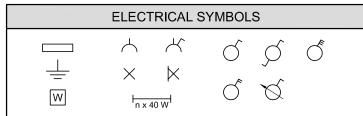

	ROOF COMPONENTS
300	ROOF CAP AND RIDGE COVER
	150 x 150 mm GUTTER
	300 x 20 mm FASCIA BOARD
	300 x 30 x 5 mm BARGE BOARD

QUESTION 4: CIVIL DRAWING

Given:

- The incomplete north elevation of a new self-contained **flatlet**, showing the walls, the sliding door and window openings, the roof and labels
- The incomplete floor plan showing the walls, steps, position of the doors, windows, fixtures and the electrical layout
- A schematic diagram of a roof truss for roof 'A' and roof notes
- Room designations and floor finishes
- The incomplete foundation and external wall detail
- A window and door schedule
- A table of fixtures
- A table of electrical symbols
- A table of roof components
- The incomplete floor plan of the new self-contained flatlet, drawn to scale 1:50, and the incomplete foundation and break line for the detailed section, drawn to scale 1:20, on page 6

Instructions:

Answer this question on page 6.

4.1 Using the given incomplete floor plan, draw, in first-angle orthographic projection and to scale 1:50, the following

views of the new self-contained flatlet: 4.1.1 THE COMPLETE FLOOR PLAN

Add the following features to the drawing:

- ALL doors and windows
- The fixtures as indicated by the abbreviations
- ALL electrical fittings as indicated by the numbers
- ALL hatching detail

4.1.2 THE COMPLETE NORTH ELEVATION

Show the following features on the drawing:

- The outside walls, steps, window and door detail
- The roof detail, including the barge boards, fascia board, gutter and rainwater down-pipe
- The finished floor level
- 4.2 Using the incomplete foundation on page 6, draw, to scale 1: 20, a **DETAILED SECTION** on cutting plane A-A of the area in the ellipse shown on the incomplete

Show the following features on the drawing:

- The complete foundation and external wall detail
- The window detail
- The roof detail, including the fascia board, gutter and barge board
- The bath
- ALL hatching detail. ONLY the substructure hatching may be drawn in neat freehand.


Label the following:


- The north elevation
- The room designations and floor finishes
- Ground level, finished floor level and damp-proof course (use the correct abbreviations and show it on ALL the relevant views)

NOTE:

ALL drawings must comply with the guidelines and graphical **symbols** as contained in the SANS 10143. [94]



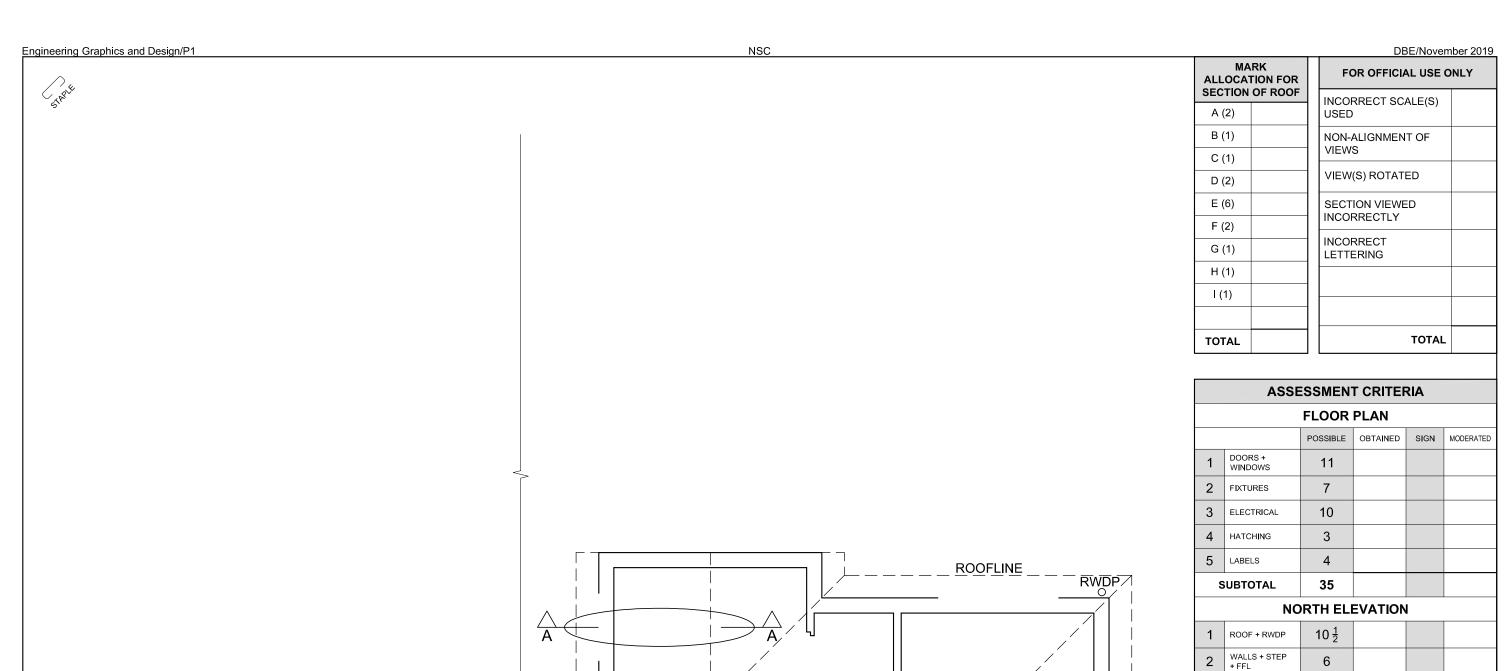

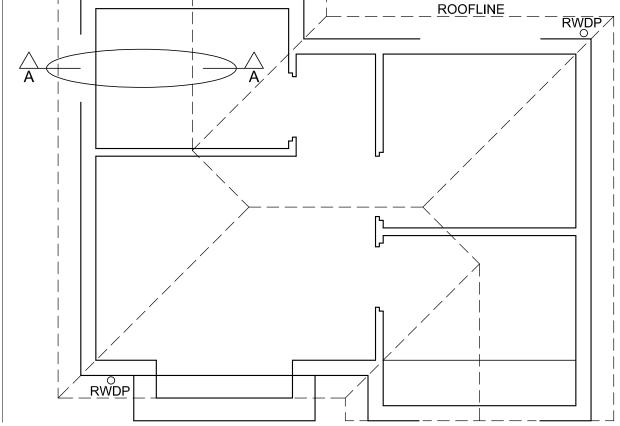

FLOOR PLAN

SCALE 1:50

WALLS + STEP + FFL DOOR + WINDOW 7 $1\frac{1}{2}$ 4 LABELS 25 SUBTOTAL **DETAILED SECTION** 1 ROOF DETAIL 16 FOUNDATION + WALL + WINDOW 10 3 ватн 1 $5\frac{1}{2}$ HATCHING $1\frac{1}{2}$ 5 LABELS SUBTOTAL 34 94 TOTAL PENALTIES (-) **GRAND TOTAL EXAMINATION NUMBER** 6 **EXAMINATION NUMBER**

DETAILED SECTION A-A

SCALE 1:20